GENERAL

- THESE DRAWINGS SHALL BE READ IN CONJUNCTION WITH ALL ARCHITECTURAL & OTHER WORKING DRAWINGS, SPECIFICATIONS & WITH SUCH WRITTEN INSTRUCTIONS AS MAY BE ISSUED DURING THE COURSE OF THE CONTRACT.
- ALL WORKMANSHIP & MATERIALS SHALL BE IN ACCORDANCE WITH THE REQUIREMENTS OF THE CURRENT EDITION OF THE RELEVANT AUSTRALIAN STANDARDS, THE BUILDING CODE OF AUSTRALIA AND ANY OTHER APPLICABLE AUTHORITY REQUIREMENTS.
- ANY CONFLICT BETWEEN THESE NOTES, THE SPECIFICATION, THE DRAWINGS OR ANY OTHER RELEVANT DOCUMENTS SHALL BE REFERRED TO THE ENGINEER FOR DECISION PRIOR TO PROCEEDING WITH THE WORK
- DIMENSIONS SHALL NOT BE OBTAINED BY SCALING THE DRAWINGS. FOR SETTING OUT DIMENSIONS & LEVELS REFER TO ARCHITECTURAL DRAWINGS.
- THE BUILDER SHALL BE RESPONSIBLE FOR THE PROVISION OF ALL SHORING TO MAINTAIN THE STABILITY & INTEGRITY OF EXCAVATIONS & ADJACENT STRUCTURES
- IT IS THE CONTRACTOR'S RESPONSIBILITY TO LOCATE ALL SERVICES PRIOR TO COMMENCEMENT OF NAY EARTHWORKS.
- ALL DIMENSIONS ARE IN MILLIMETERS UNLESS NOTED OTHERWISE.



STORMWATER

- 1. ALL LEVELS ARE TO A.H.D. UNO
- THE STORMWATER SYSTEM IS DESIGNED TO COMPLY WITH COUNCIL'S DESIGN CRITERIA AND TO APPROXIMATELY MAINTAIN EXISTING FLOW PATTERNS
- OVERLAND FLOW PATHS ARE PRESERVED.
- EXISTING DRAINAGE AND LEVELS ARE BASED ON SURVEY PROVIDED & SHOULD BE ASSUMED TO BE APPROXIMATE. ALLOW TO CONFIRM ALL RELEVANT DETAILS BEFORE PROCEEDING WITH AFFECTED AREAS.
- STORMWATER DESIGN AND WORKS TO COMPLY WITH COUNCIL'S DCP, DESIGN CRITERIA AND AS3500.
- ALL PITS TO BE PRECAST CONCRETE OR F.R..C. UNO.
- DOWNPIPE LOCATIONS SHOULD BE CONFIRMED WITH 7. ARCHITECTURAL PLANS UNO
- GRADE LOCAL SURFACES INTO PITS TO ENSURE COLLECTION OF WATER & THAT THERE ARE NO AREAS OF PONDING, TYPICAL
- GRATED TRENCHES AND SILT ARRESTOR PITS TO BE INSPECTED AND CLEANED AFTER PERIODS OF HEAVY RAINFALL.
- 10. TREE ROOTS TO BE AVOIDED DURING PLACEMENT OF DRAINAGE SYSTEM.
- 11. ALL PIPES TO BE Ø100 UPVC UNO.
- 12. ALL PIPES TO HAVE 100MIN. COVER IN LANDSCAPED AREAS AND 600. MIN. COVER IN TRAFFICABLE AREAS.
- 13. ALL INLET AND OUTLET PIPES FROM PITS TO BE CONNECTED AT THE HIGHEST POSSIBLE INVERT LEVEL WHILST KEEPING 1% MIN. GRADE
- 14. FINISHED SURFACES TO BE GRADED AWAY FROM THE DWELLING AND TOWARD THE PITS.
- 15. GRATED TRENCHES TO BE 1% MIN. GRADE THROUGHOUT TO OUTI FT PIPF
- 16. FINISHED CROSSING AND DRIVEWAY LEVELS ARE BASED ON SURFACE LEVELS OF THE EXISTING LAYBACK AND STREET BOUNDARY LEVELS.
- 17. BEFORE COMMENCING CONSTRUCTION OF THE CROSSING AND DRIVEWAY. COUNCIL'S DESIGNED STREET BOUNDARY LEVELS MUST BE OBTAINED AND USED FOR CONSTRUCTION.

SOIL AND WATER MANAGEMENT NOTES

- ALL EROSION AND SEDIMENT CONTROL MEASURES TO BE INSPECTED AND MAITAINED DAILY BY SITE MANAGER
- MINIMISE DISTURBED AREAS
- ALL STOCKPILES TO BE CLEAR FROM DRAINS, GUTTERS AND FOOTPATHS.
- DRAINAGE TO BE CONNECTED TO STORMWATER SYSTEM AS SOON AS POSSIBLE.
- ROADS AND FOOTPATHS TO BE SWEPT DAILY AND KEPT CLEAN AT **ALL TIMES**
- INSTALL TEMPORARY SEDIMENT BARRIERS TO ALL INLET PITS LIKELY 6. TO COLLECT SILT LADDEN WATER, TO COUNCILS'S REQUIREMENTS.
- NOT WITHSTANDING DETAILS SHOWN, IT IS THE SITE MANAGERS SOLE RESPONSIBILITY TO ENSURE THAT ALL SITE ACTIVITIES COMPLY WITH THE REQUIREMENTS OF THE CLEAN WATERS ACT.


SEDIMENT CONTROL NOTES

- 1. ALL EROSION AND SEDIMENTATION CONTROL MEASURES, INCLUDING REVEGETATION AND STORAGE OF SOIL AND TOPSOIL, SHALL BE IMPLEMENTED TO THE STANDARDS OF THE SOIL CONSERVATION OF
- ALL DRAINAGE WORKS SHALL BE CONSTRUCTED AND STABILISED AS EARLY AS POSSIBLE DURING DEVELOPMENT.
- SEDIMENT TRAPS SHALL BE CONSTRUCTED AROUND ALL INLET PITS, CONSISTING OF 300mm WIDE X 300mm DEEP TRENCH.
- ALL SEDIMENT BASINS AND TRAPS SHALL BE CLEANED WHEN THE STRUCTURES ARE A MAXIMUM OF 60 % FULL OF SOIL MATERIALS, INCLUDING THE MAINTENANCE PERIOD.
- ALL DISTURBED AREAS SHALL BE REVEGITATED AS SOON AS THE RELEVANT WORKS ARE COMPLETED.
- SOIL AND TOPSOIL STOCKPILES SHALL BE LOCATED AWAY FROM DRAINAGE LINES AND AREA WHERE WATER MAY CONCENTRATE.
- 7. FILTER SHALL BE CONSTRUCTED BY STRETCHING A FILTER FABRIC (PROPEX OR APPROVED EQUIVALENT BETWEEN POST AT 3.0m CENTRES. FABRIC SHALL BE BURIED 150mm ALONG ITS LOWER EDGE.



CLIENT:

DRAWING TITLE:

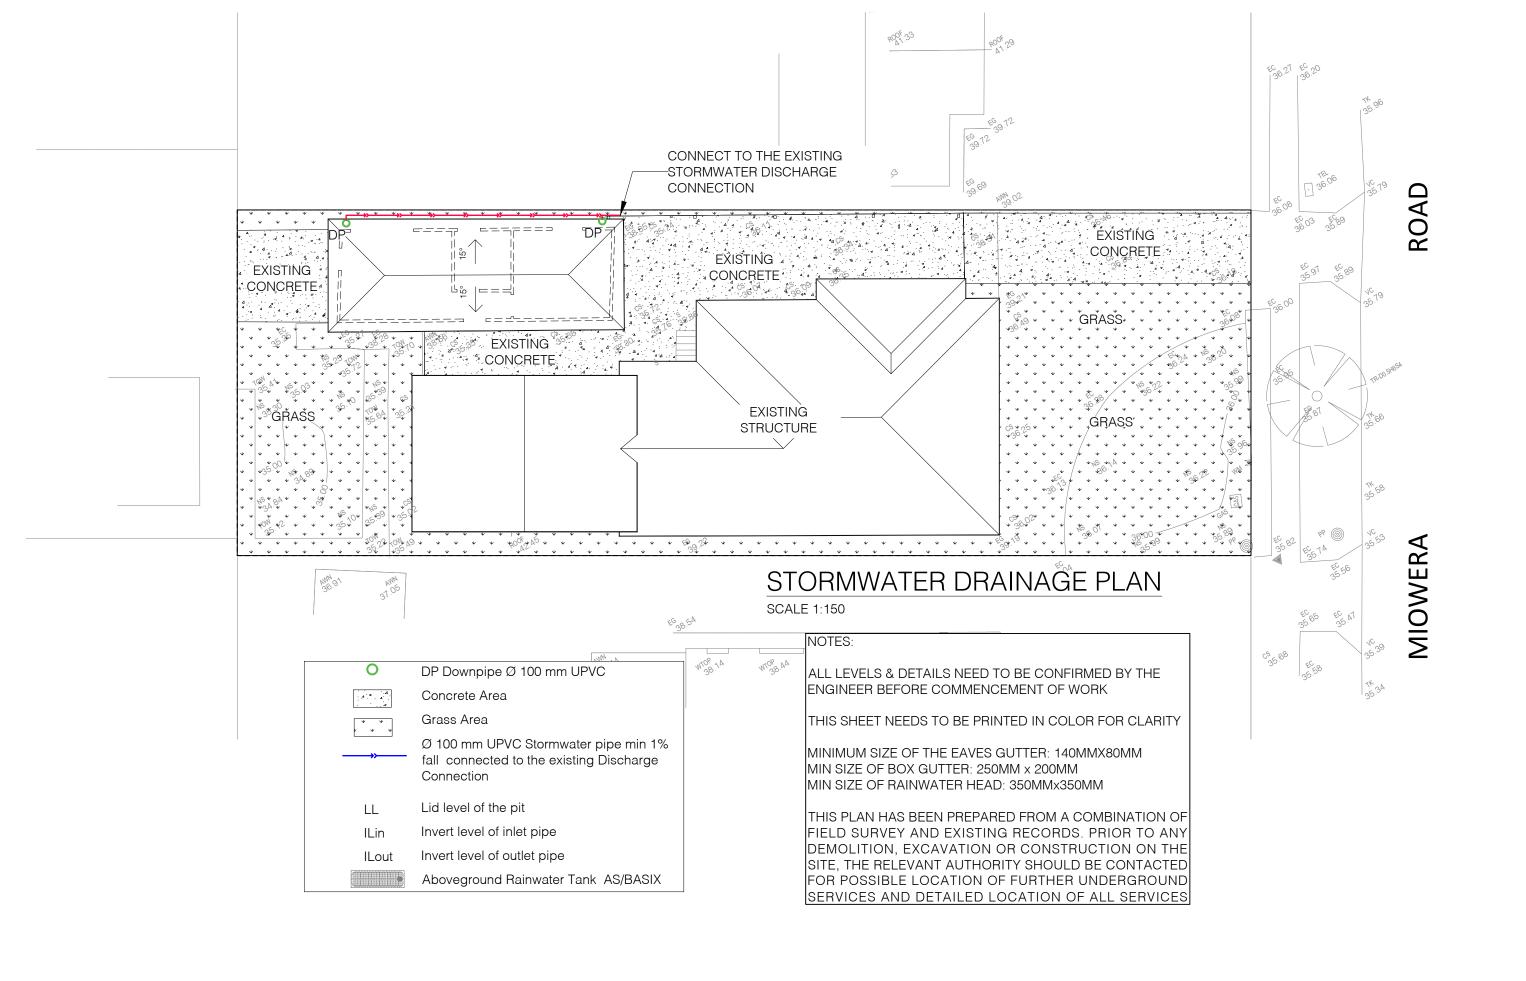



CONSULTANTS: E: info@tpc-eng.com.au A: 13/35 Birch Street, Condell Park NSW 2200

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REV	DATE	DESCRIPTION	
1	21/09/23		

COUNCIL: DRAWN BY:

DESIGNED BY: CLIENT:

DRAWING TITLE: Stormwater Drainage Plan

Canterbury Bankstown Council


R.D


SITE ADDRESS: 36 Miowera Rd, Chester Hill NSW 2162 LOT:136 | SEC: **DP:**16897

ISSUED FOR:


PROJECT: Secondary Dwelling


SCALE: 1:150 @ A3 DATE: 21/09/23 REV: R1 SHEET NO.:

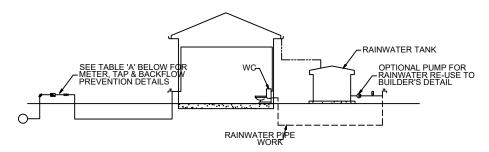

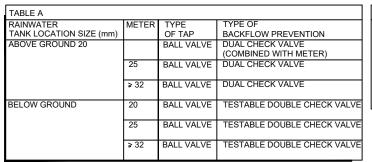

LEGEND PRESSURE VESSEL METER BALL VALVE RIGHT ANGLE TYPE DUAL CHECK VALVE PUMP TOWN GARDEN TAP DRINKING WATER SUPPLY PIPES RAINWATER SUPPLY PIPES DOWN PIPES

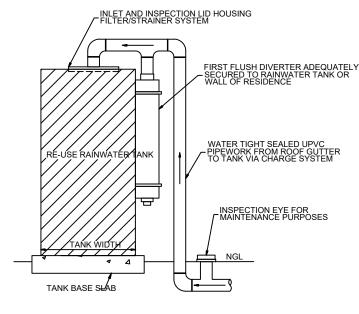

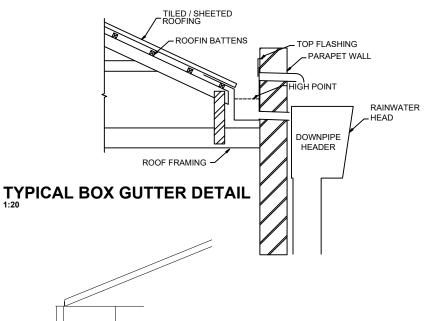

DUAL DRINKING WATER & RAINWATER SUPPLY DIAGRAM

DIAGRAM NOTES:

1. DRAWING TO BE READ IN CONJUNCTION WITH SYDNEY WATER PLUMBING REQUIREMENTS

2. FOR TANKS 10,000 LITRES OR LESS. COUNCIL DEVELOPMENT CONSENT IS NOT REQUIRED. IF THEIR CONDITIONS FOR INSTALLATION ARE FOLLOWED.

3. FOR TANKS GREATER THAN 10,000 LITRES COUNCIL DEVELOPMENT CONSENT IS GENERALLY REQUIRED.

4. FOR TANKS MORE THAN 10,000 LITRES APPROVAL IS REQUIRED FOR BUILDING OVER SEWERS.


5. SYDNEY WATER'S APPROVAL IS REQUIRED FOR ANY TOP UP FROM DRINKING WATER SUPPLY, REGARDLESS OF TANK SIZE. NO DIRECT CONNECTION IS ALLOWED BETWEEN THE DRINKING WATER SUPPLY AND THE RAINWATER TANK SUPPLY.


6. RAINWATER TANK SUPPLY.


6. RAINWATER THE WORLD STERNAL RAINWATER USES. CUSTOMERS MAY WANT ONE OR THE OTHER.

7. ANY DESIGNED ACCESS LID INTO RAINWATER RE-USE TANK IS TO HAVE A LOCKABLE LID. IF THE LID IS DESIGNED TO BE ACCESSED BY A MAINTENANCE PERSON, IT MUST BE AT LEAST 600 mm x 900 mm IN SIZE.




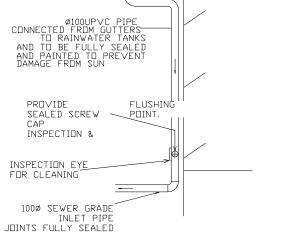

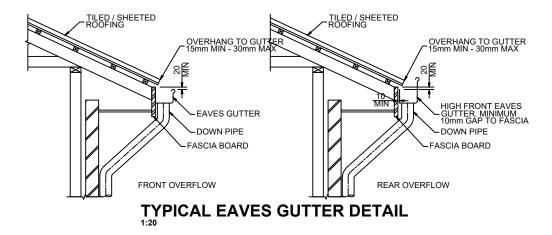

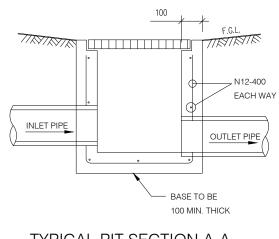

TYPICAL PIT SECTION A-A

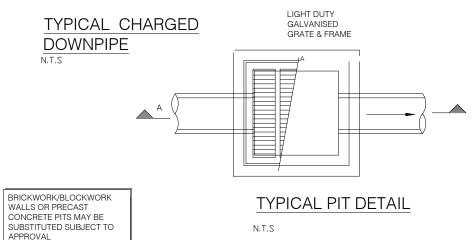

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KEV	DATE	DESCRIPTION
1	21/09/23	_

COUNCIL: Canterbury Bankstown Council

DRAWN BY: DESIGNED BY: R.D CLIENT:

DRAWING TITLE: Typical Stormwater Details SITE ADDRESS: 36 Miowera Rd, Chester Hill NSW 2162 LOT:136 | SEC: **DP:**16897

ISSUED FOR:

SCALE: NTS

PROJECT: Secondary Dwelling

21/09/23

REV: R1 SHEET NO.: